LEGEND

PROPOSED VCP SEWER MAIN

PROPOSED SEWER MANHOLE

CONSTRUCTION NOTES

(1) CONSTRUCT 48" ID MANHOLE PER CITY OF RIVERSIDE STD DWG NO. 500.	7 EA.
(2) CONSTRUCT 8" VCP EXTRA STRENGTH SEWER MAIN.	1088 L.F.
(3) CONSTRUCT 6" SEWER LATERAL PER CITY OF RIVERSIDE STD DWG NO. 562.	70 L.F.
(4) CONSTRUCT SEWER MAIN BEDDING PER CITY OF RIVERSIDE STD DWG NO. 452 (CASE 1, LOAD FACTOR 1.5).	1088 L.F.


BASIS OF BEARING:

BASIS OF BEARINGS: BEARINGS ARE BASED ON THE NORTH LINE OF PARCEL 15 AS SHOWN BY PARCEL MAP NO. 24536 ON FILE IN BOOK 162 OF PARCEL MAPS, PAGES 91-98 THEREOF, RECORDS OF RIVERSIDE COUNTY, CALIFORNIA, BEING N89'09'10"E.

BENCH MARK

CITY OF RIVERSIDE POINT I.D.: L1-A3 P.K. NAIL AND CITY ENGINEER TAG IN THE BASE OF A STREET LIGHT POLE ALONG THE NORTHERLY CURB OF EASTRIDGE AVENUE, 82 FEET WESTERLY OF BOX SPRINGS BOULEVARD. ELEVATION: 1534.311

IN THE CITY OF RIVERSIDE SEWER PLAN

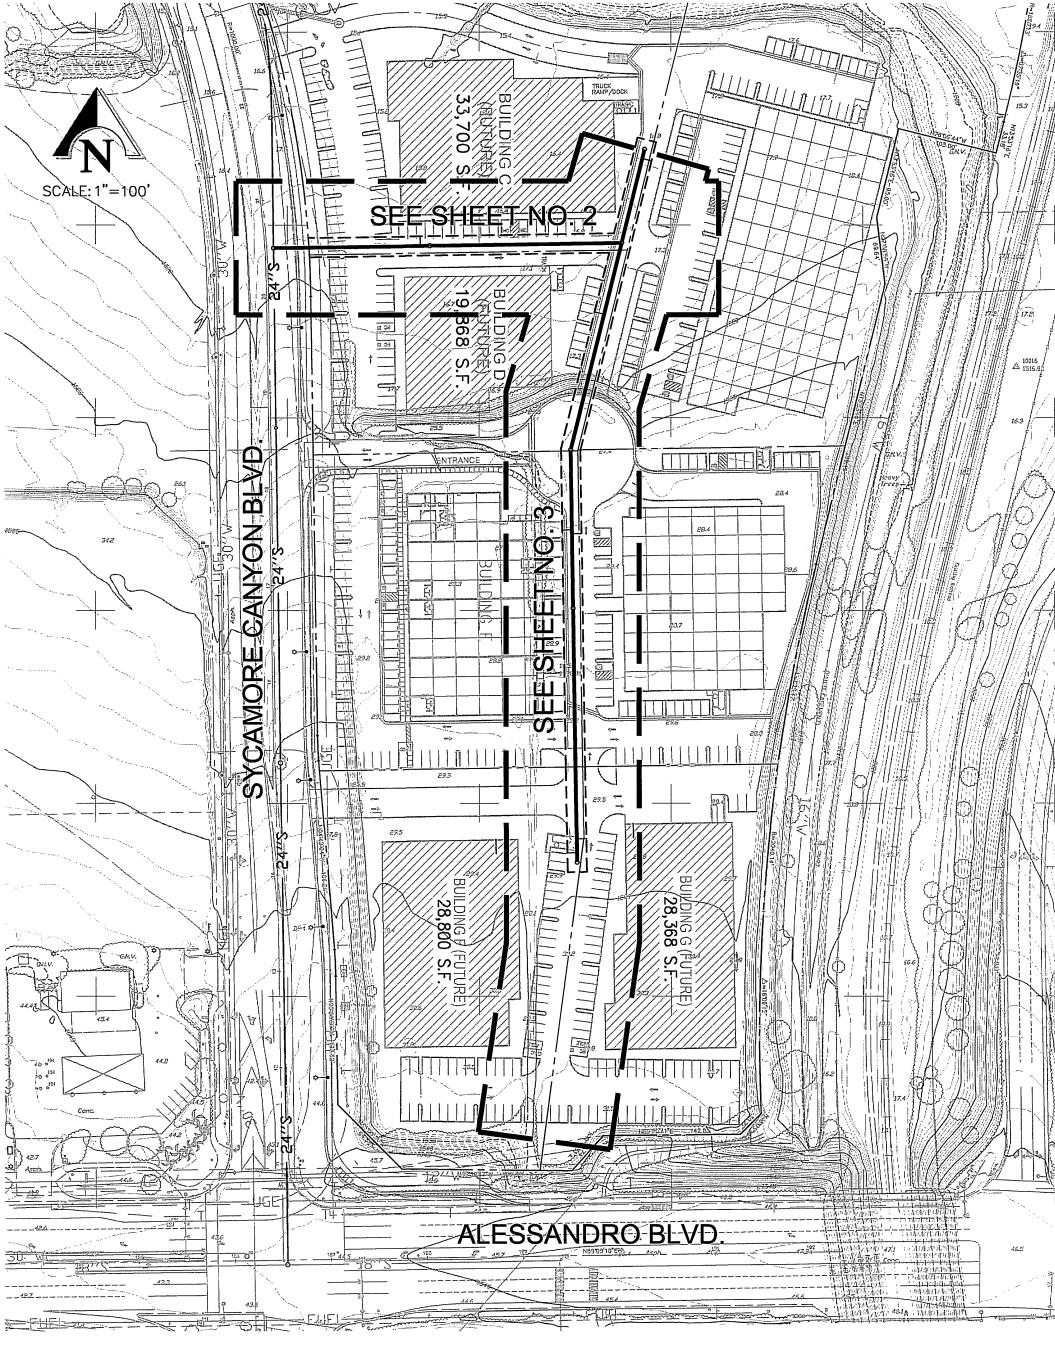

INDEX MAP

SCALE: 1"=100'

SHEET 1 TITLE SHEET SHEET 2 SHEET 3

SHEET INDEX

SEWER LINE "A" PLAN & PROFILE SEWER LINE "B" PLAN & PROFILE

Underground Service Alert

227-2600

TWO WORKING DAYS BEFORE YOU DIG


PRIVATE ENGINEERING NOTE CONSTRUCTION CONTRACTOR AGREES THAT IN ACCORDANCE WITH GENERALLY ACCEPTED CONSTRUCTION PRACTICES, CONSTRUCTION CONTRACTOR WILL BE REQUIRED TO ASSUME SOLE AND COMPLETE RESPONSIBILITY FOR JOB SITE CONDITIONS DURING THE COURSE OF CONSTRUCTION OF THE PROJECT, INCLUDING SAFETY OF ALL PERSONS AND PROPERTY; THAT THIS REQUIREMENT SHALL BE MADE TO APPLY CONTINUOUSLY AND NOT BE LIMITED TO NORMAL WORKING HOURS, AND CONSTRUCTION CONTRACTOR FURTHER

AGREES TO DEFEND, INDEMNIFY AND HOLD DESIGN


PROFESSIONAL HARMLESS FROM ANY AND ALL LIABILITY,

OF WORK ON THIS PROJECT, EXCEPTING LIABILITY ARISING FROM THE SOLE NEGLIGENCE OF DESIGN PROFESSIONAL.

REAL OR ALLEGED, IN CONNECTION WITH THE PERFORMANCE

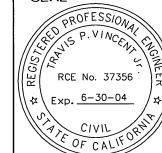

PREPARED UNDER THE SUPERVISION OF:

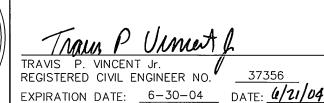

KCT CONSULTANTS, INC. Civil Engineers - Surveyors - Planners P.O. Box 5705 Riverside, CA 92517-5705 4344 Latham St., Suite 200, Riverside, CA 92501 Phone: 909/341-8940 Fax: 909/341-8945 e-mail: kctinc@kctconsultants.com

AS NOTED

DATE: FEBRUARY 2004

CITY BUSINESS TAX CERTIFICATE NO.: 069540 EXP. DATE: 04-07-05

SEE SHEET NO. 1

PUBLIC WORKS DEPARTMENT DATE BY APPROVED BY: PRINCIPAL ENGINEER 19 CAN TRAFFIC DIVISION APPR. DATE REVISIONS

TRVZ

DRAWN BY AG CHECKED BY TPV

//m/ 150g CITY ENGINEER

OF RIVERSIDE

GENERAL NOTES

plans for approval by the City.

notification from the City inspectors.

result of construction shown hereon.

responsible for their accuracy.

1. The private engineer signing these plans is responsible for assuring the accuracy and acceptability of the work hereon. In the event of

discrepancies arising during construction, the private engineer shall be responsible for determining an acceptable solution and revising the

2. It shall be the responsibility of the contractor to clear the right of way in accordance with the provisions of law as it affects each utility

3. Construction shall be in accordance with the City of Riverside Dept. of Public Works, Standard Drawings, its Supplemental Notes and the Standard Specifications for Public Works Construction, Current Edition.

4. Contractor is to verify existing sewer elevation prior to construction.

6. A plug shall be installed and will remain in place where the new sewer connects with the existing sewer until the new sewer is accepted by the City of Riverside.

7. Any traffic control striping obliterated and/or badly worn during

8. All flagged elevations shall be staked in the field by the private

5. The sewer contractor shall adjust manholes to final grade after paving

construction shall be restored by the contractor within five days after

9. The contractor shall call in a locations request to UNDERGROUND SERVICE ALERT (USA), Phone No. 1—800—227—2600, two working days before digging No construction permit will be issued by the Public Works Department

and referencing survey monuments destroyed, disturbed or buried as a

involving excavation for underground facilities unless the applicant has been provided an Inquiry Identification Number by U.S.A.

11. Notice to contractor. The existence and location of any underground utility pipes or structures shown on these plans were obtained by a search of available records. To the best of our knowledge there are

15. Prior to construction the contractor shall pothole all utility crossings and connections and verify the location and elevation of all utilities affected. The engineer shall be notified of any discrepancies before

16. No person shall perform any construction activity or install any objects within the public right-of-way or easements of the City of Riverside without a valid Construction permit or, a Street Opening permit or an Encroachment permit issued by the City's Public Works Department.

17. On all areas within public right—of—way where the fill is one (1) foot or greater, a letter will be required from the soils engineer, certifying the

18. Quantities shown are for information only and the City of Riverside is not

19. Location of laterals to be determined in the field at the direction of the

20. No finished floor elevations shall be less than 6" above upper manhole rim elevation of the sewer line segment being connected to, without having a

owner. Avoid conflict with proposed and/or existing facilities.

proper backwater valve installed in the lateral.

compaction of the fill below subgrade, prior to issuance of the Construction

no existing utilities except as shown on these plans. The contractor is required to take precautionary measures to protect the utility lines shown on any other lines not of record or not shown on these plans.

10. The developer shall be responsible for preserving or reestablishing

including irrigation lines and appurtenances and at no cost to the City


IN THE CITY OF RIVERSIDE, COUNTY OF RIVERSIDE, STATE OF CALIFORNIA SEWER PLAN AND PROFILE TITLE SHEET PM 31802 SYCAMORE CANYON BOULEVARD N'LY OF ALESSANDRO BOULEVARD


FILE NO.: KCT WO: 1250-06

S-1844

PW04-0318

JIM GUTHRIE CONSTRUCTION INDEXED 12-9-04 4H

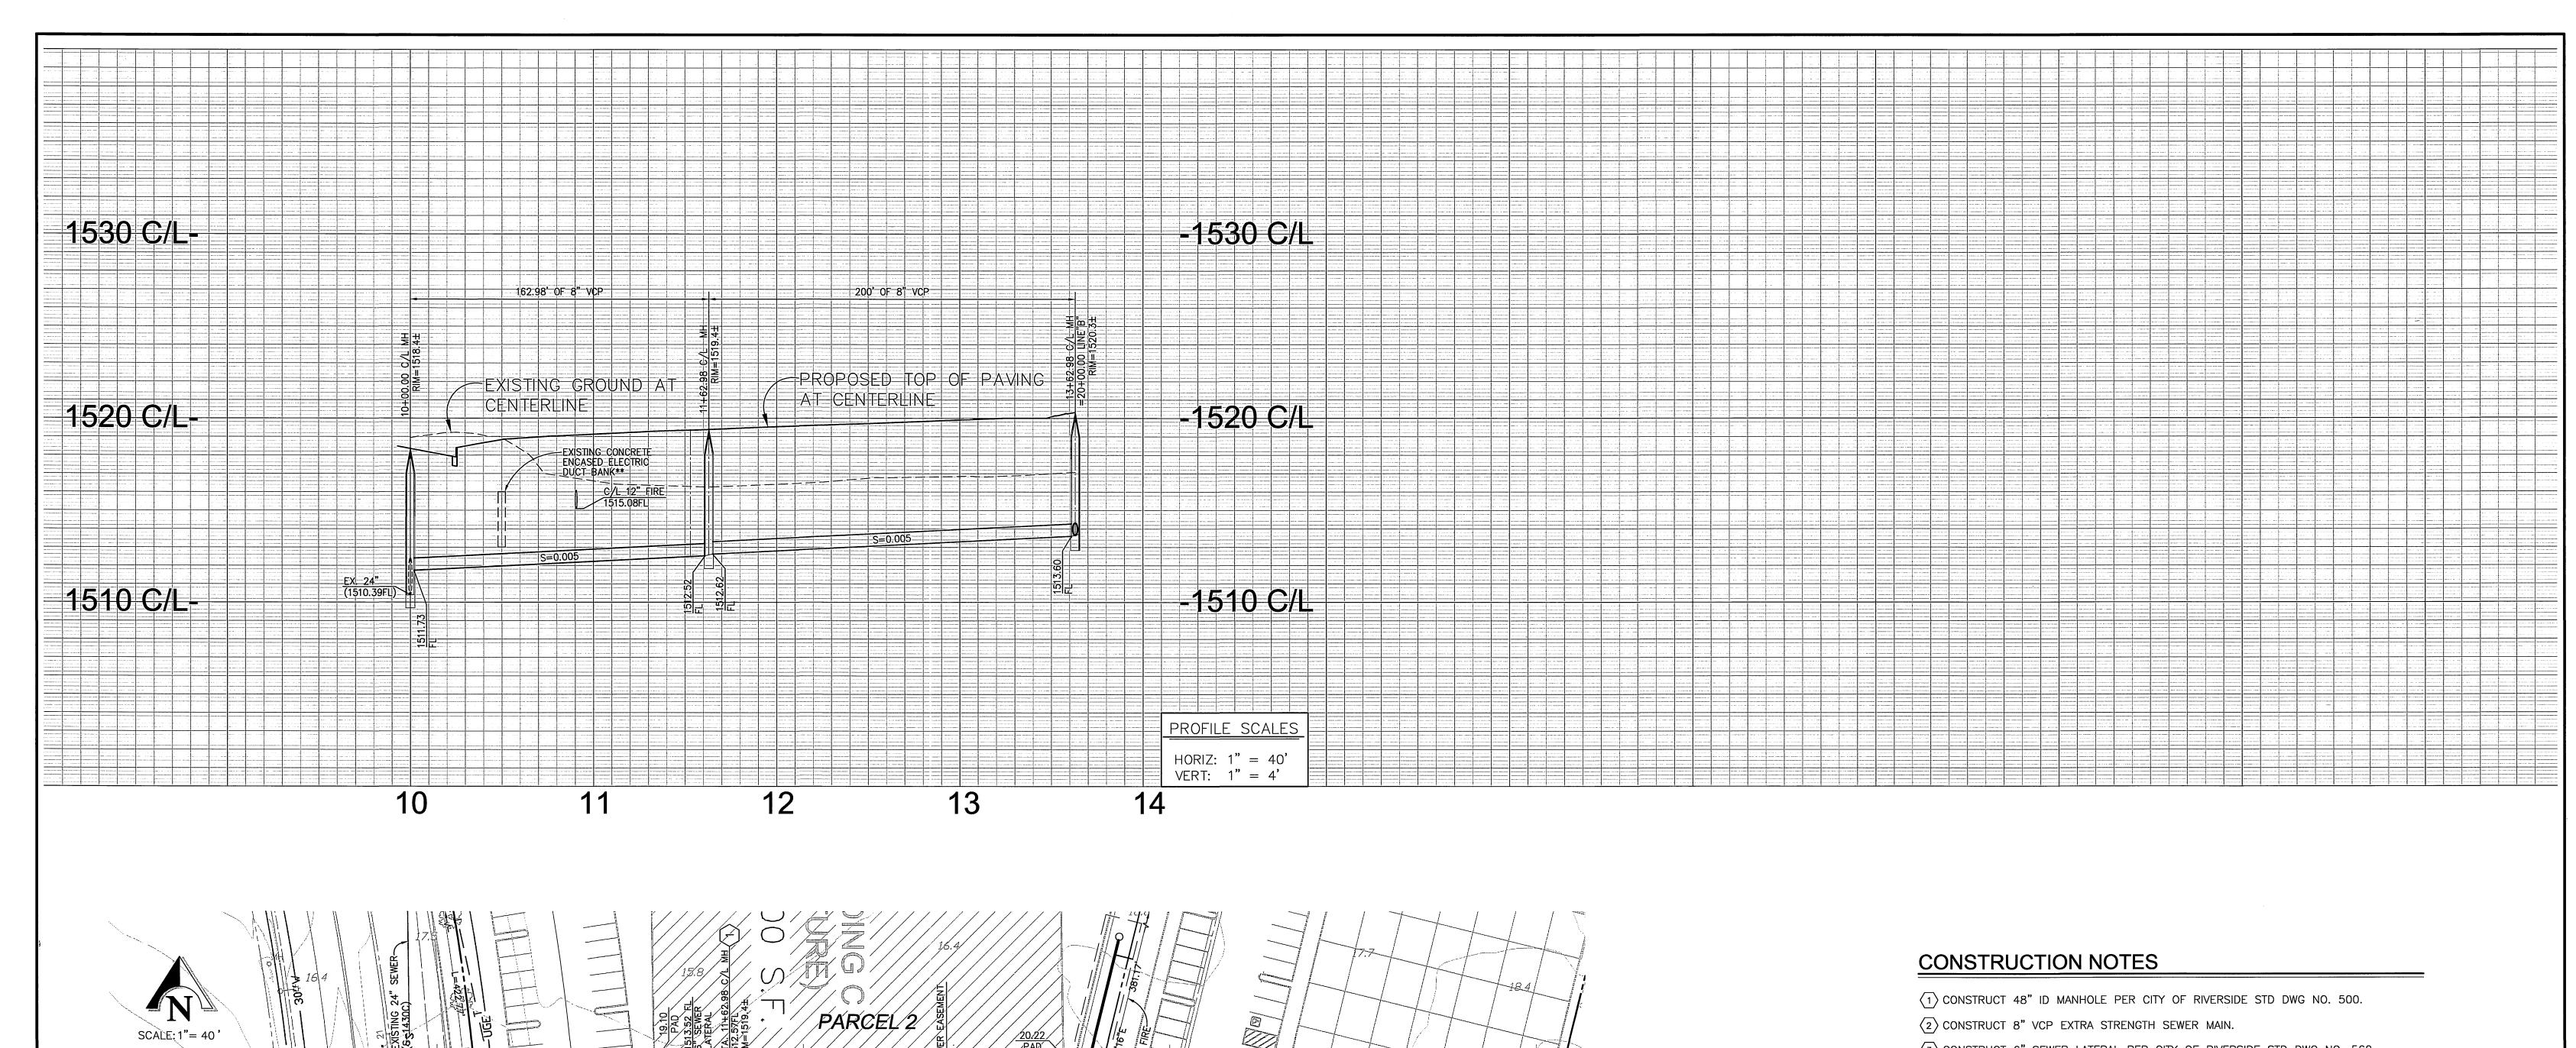


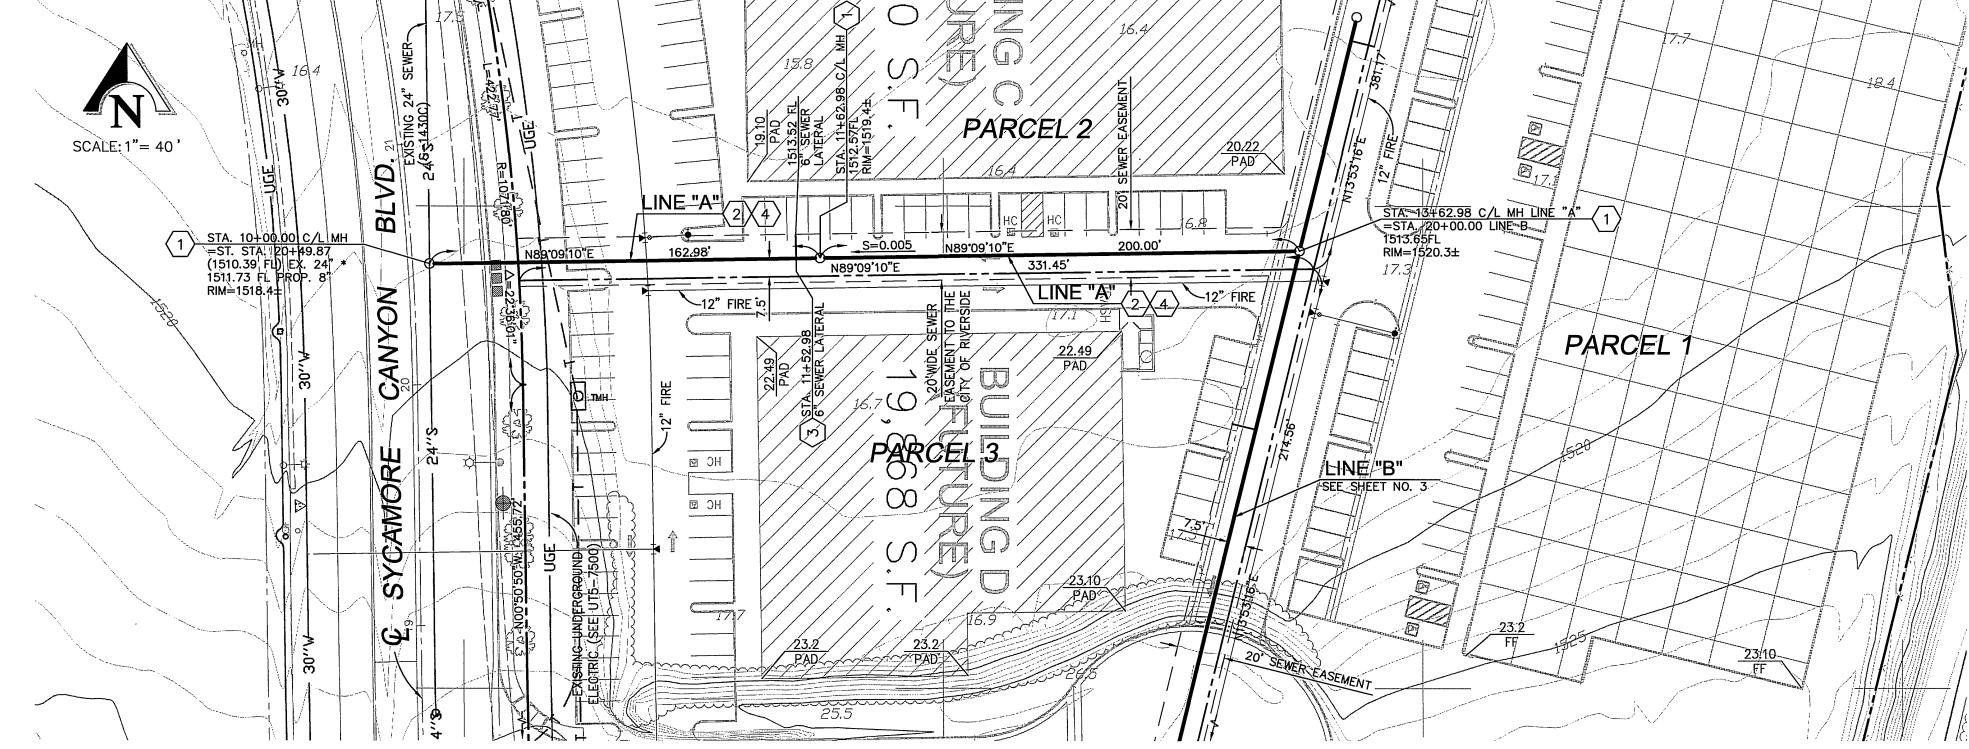

- $\overline{3}$ CONSTRUCT 6" SEWER LATERAL PER CITY OF RIVERSIDE STD DWG NO. 562.
- (4) CONSTRUCT SEWER MAIN BEDDING PER CITY OF RIVERSIDE STD DWG NO. 452 (CASE 1, LOAD FACTOR 1.5).

** USE CAUTION AROUND EXISTING CONCRETE ENCASED ELECTRICAL DUCT BANK.

* CONTRACTOR TO VERIFY EXISTING ELEVATION PRIOR TO THE START OF CONSTRUCTION AND NOTIFY ENGINEER OF ANY DISCREPANCIES

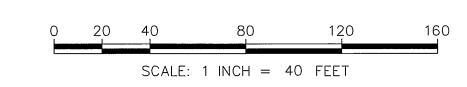

Underground Service Alert TOLL FREE 1-800 227-2600

TWO WORKING DAYS BEFORE YOU DIG

PRIVATE ENGINEERING NOTE CONSTRUCTION CONTRACTOR AGREES THAT IN ACCORDANCE WITH GENERALLY ACCEPTED CONSTRUCTION PRACTICES, CONSTRUCTION CONTRACTOR WILL BE REQUIRED TO ASSUME SOLE AND COMPLETE RESPONSIBILITY FOR JOB SITE CONDITIONS DURING THE COURSE OF CONSTRUCTION OF THE PROJECT, INCLUDING SAFETY OF ALL PERSONS AND PROPERTY; THAT THIS REQUIREMENT SHALL BE MADE TO APPLY CONTINUOUSLY AND NOT BE LIMITED TO NORMAL WORKING HOURS, AND CONSTRUCTION CONTRACTOR FURTHER AGREES TO DEFEND INDEMNIFY AND HOLD DESIGN AGREES TO DEFEND, INDEMNIFY AND HOLD DESIGN PROFESSIONAL HARMLESS FROM ANY AND ALL LIABILITY, REAL OR ALLEGED, IN CONNECTION WITH THE PERFORMANCE OF WORK ON THIS PROJECT, EXCEPTING LIABILITY ARISING FROM THE SOLE NEGLIGENCE OF DESIGN PROFESSIONAL.

RCE No. 37356 .

SEAL

PREPARED UNDER THE SUPERVISION OF:

Maus P Vimux TRAVIS P. VINCENT Jr. REGISTERED CIVIL ENGINEER NO. SCALE: EXPIRATION DATE: 6-30-04 DATE: u/v/04

KCT CONSULTANTS, INC. Civil Engineers - Surveyors - Planners P.O. Box 5705 Riverside, CA 92517-5705 4344 Latham St., Suite 200, Riverside, CA 92501 Phone: 909/341-8940 Fax: 909/341-8945 e-mail: kctinc@kctconsultants.com

FEBRUARY 2004

CITY BUSINESS TAX CERTIFICATE NO.: 069540 EXP. DATE: 04-07-05

SEE SHEET NO. 1

REVISIONS DESIGNED BY TPV DRAWN BY AG CHECKED BY TPV

CITY OF RIVERSIDE PUBLIC WORKS DEPARTMENT DATE BY APPROVED BY: APPROVED BY Jam Bog

RINCIPAL ENGINEER 19/19/19/19

RAFFIC DIVISION

RVZ

IN THE CITY OF RIVERSIDE, COUNTY OF RIVERSIDE, STATE OF CALIFORNIA SEWER PLAN AND PROFILE PM 31802 SEWER LINE "A" STA. 10+00.00 TO 13+62.98

PW04-0318 S-1844 SHEET 2 OF 3

JIM GUTHRIE CONSTRUCTION MDEXED 12-9-04 4H

FILE NO.: KCT WO: 1250-06

